

**GROUND FLOOR PLAN** 

SCHE	EDULE OF DOOR & WINDOW :		
TYPE	SIZE	SILL LVL	REMARK
G1	3200 X 2100	00	GLAZING AS / DETAIL
G 2	1800 X 2100	00	GLAZING AS / DETAIL
G 3	1000 X 2100	00	GLAZING AS / DETAIL
G 4	1980 X 2100	00	GLAZING AS / DETAIL
D1	1000 X 2100	00	FLUSH DOOR
D 2	900 X 2100	00	PANEL AND JALI
D 3	750 X 2100	00	FLUSH DOOR
D 4	1000 X 2100	00	BRACED AND BATTEN
W 1	1800 X 1200	900	
W 2	1730 X 1200	900	
W 3			
W 4	1000 X 2000	100	
W 5	1000 X 1200	900	
W 6	900 X 1050	1050	
W 7	450 X 1200	900	
W 8	600 X 900	1200	
W 9	1200 X 1200	900	
W 10	450 X 10500	1050	GLAZED & FLY PROOF
W	900 X 500		JUST BELOW THE
			R.C.C SLAB

SCHEDULE OF DRAWINGS:			
SHEET NO	DESCRIPTION		
199 R/1 - 1	GROUND FLOOR PLAN		
199 R/1 - 2	FIRST FLOOR PLAN		
199 R/1 - 3	SECOND FLOOR PLAN		
199 R/1 - 4	THIRD FLOOR PLAN		
199 R/1 - 5	TERRACE FLOOR PLAN		
199 R/1 - 6	ELEVATION FRONT		
199 R/1 - 7	ELEVATION L.H. SIDE		
199 R/1 - 8	ELEVATION R .H. SIDE		
199 R/1 - 9	ELEVATION REAR		
199 R/1 - 10	SECTION X-X		
199 R/1 - 11	SECTION Y-Y		
199 R/1 - 12	DETAIL OF DOOR & WINDOWS		
199 R/1 - 13	DETAIL OF MAIN STAIRCASE		
199 R/1 - 14	DETAIL OF MAIN STAIRCASE		
199 R/1 - 15	DETAIL OF KITCHEN & TOILET		
199 R/1 - 16	DETAIL OF KITCHEN & TOILET		
199 R/1 - 17	DETAIL OF STEEL RAILING		
	,		

## JOINING DETAIL



# HOUSING & URBAN PROJECT WINGS

DATE : 4TH JAN 1983

## SCHEDULE OF AREA:

1.	AREA OF UNIT 1 :	CAT III	GROUND FLR	110.89 SQ.M.
2.	AREA OF UNIT 2 :	CAT III	GROUND FLR	110.89 SQ.M.
3.	AREA OF UNIT 3 :	CAT III	FIRST FLR	112.09 SQ.M.
4.	AREA OF UNIT 4 :	CAT II	FIRST FLR	88.09 SQ.M.
5.	AREA OF UNIT 5 :	CAT II	SECOND FLR	96.31 SQ.M.
6.	AREA OF UNIT 6 :DUPLEX	CAT III	SECOND FLR	114.46 SQ.M.
7.	AREA OF UNIT 7 :	CAT II	THIRD FLR	88.09 SQ.M.
8.	AREA OF STAIRCASE ON EACH FLOOR			5.41 SQ.M.
9.	AREA OF GARAGE		3.11 SQ.M.	

NOTES:-

- ALL DIMENSIONS ARE IN MM. • DWG. NOT TO BE SCALED ONLY WRITTEN DIMENSION TO BE FOLLOWED.
- ALL DIMENSION SHOULD BE CHECKED AT SITE BEFORE EXECUTION OF WORK.
- STRUCTURAL DWG. SHOULD BE GET APPROVED BY ARCHITECT.
- ARCHITECT SHOULD BE CONSULTED AT THE TIME OF PREP. OF NIT.
- ELECTRICAL LAYOUT SHOULD BE GET APPROVED BY THE ARCHITECT.
- NOTHING SHOULD BE CHANGED WITHOUT THE CONSENT OF AN ARCHITECT.

SPECIFICATON:

- INSIDE FLOORING SHOULD BE MOSSIAC IN GREY CEMENT.
- ALL TOILETS SHALL HAVE 2100 HIGH GLAZED TILE DADO.
- KITCHEN SHOULD HAVE GLAZED TILE/MOSSAC DADO AS PER DETAIL.
- PCC TILES FLOORING ON TERRACE.
- STD. STEEL SECTION SHALL BE USED IN GLAZING & WINDOWS.
- PRESSED STEEL FRAMES SHALL BE USED IN DOORS.
- ANGLE IRON FRAME SHALL BE USED IN TERRACE.

STANDARD DESIGN FOR 3 BED

ROOM & 2 BED ROOM HOUSES

#### NOTE:

THIS DRAWING HAS BEEN DIGITIZED/ RASTERED IN AUTOCAD VERSION FROM ORIGINAL DRAWING (TRACING) STANDARD UNIT PLAN SCHEME NO.199R. FOR ANY OFFICIAL USE ORIGINAL TRACING NEEDS TO BE REFERRED.

PROJECT TITLE :

I	N
W	E

DRG. NO.

SHEET TITLE : GROUND FLOOR PLAN

ROUND FL	Sch.no. 199R	
ARCH. ASSTT.	ASSTT. ARCH.	ARCHITECT
SR. ARCHITECT	ADD. CH. ARCH.	CHIEF ARCH.

DATE : SEPT., 2010

SCALE	:	l:50
-------	---	------




HOUSING & URBAN PROJECT WING, OFFICE OF THE SR. ARCHITECT, EAST ZONE, VIKAS MINAR, D.D.A.

RCH. ASS ADD. CH. ARCH. SR. ARCHITECT

CHIEF ARCH.

DIGITIZED BY

Allot Jos

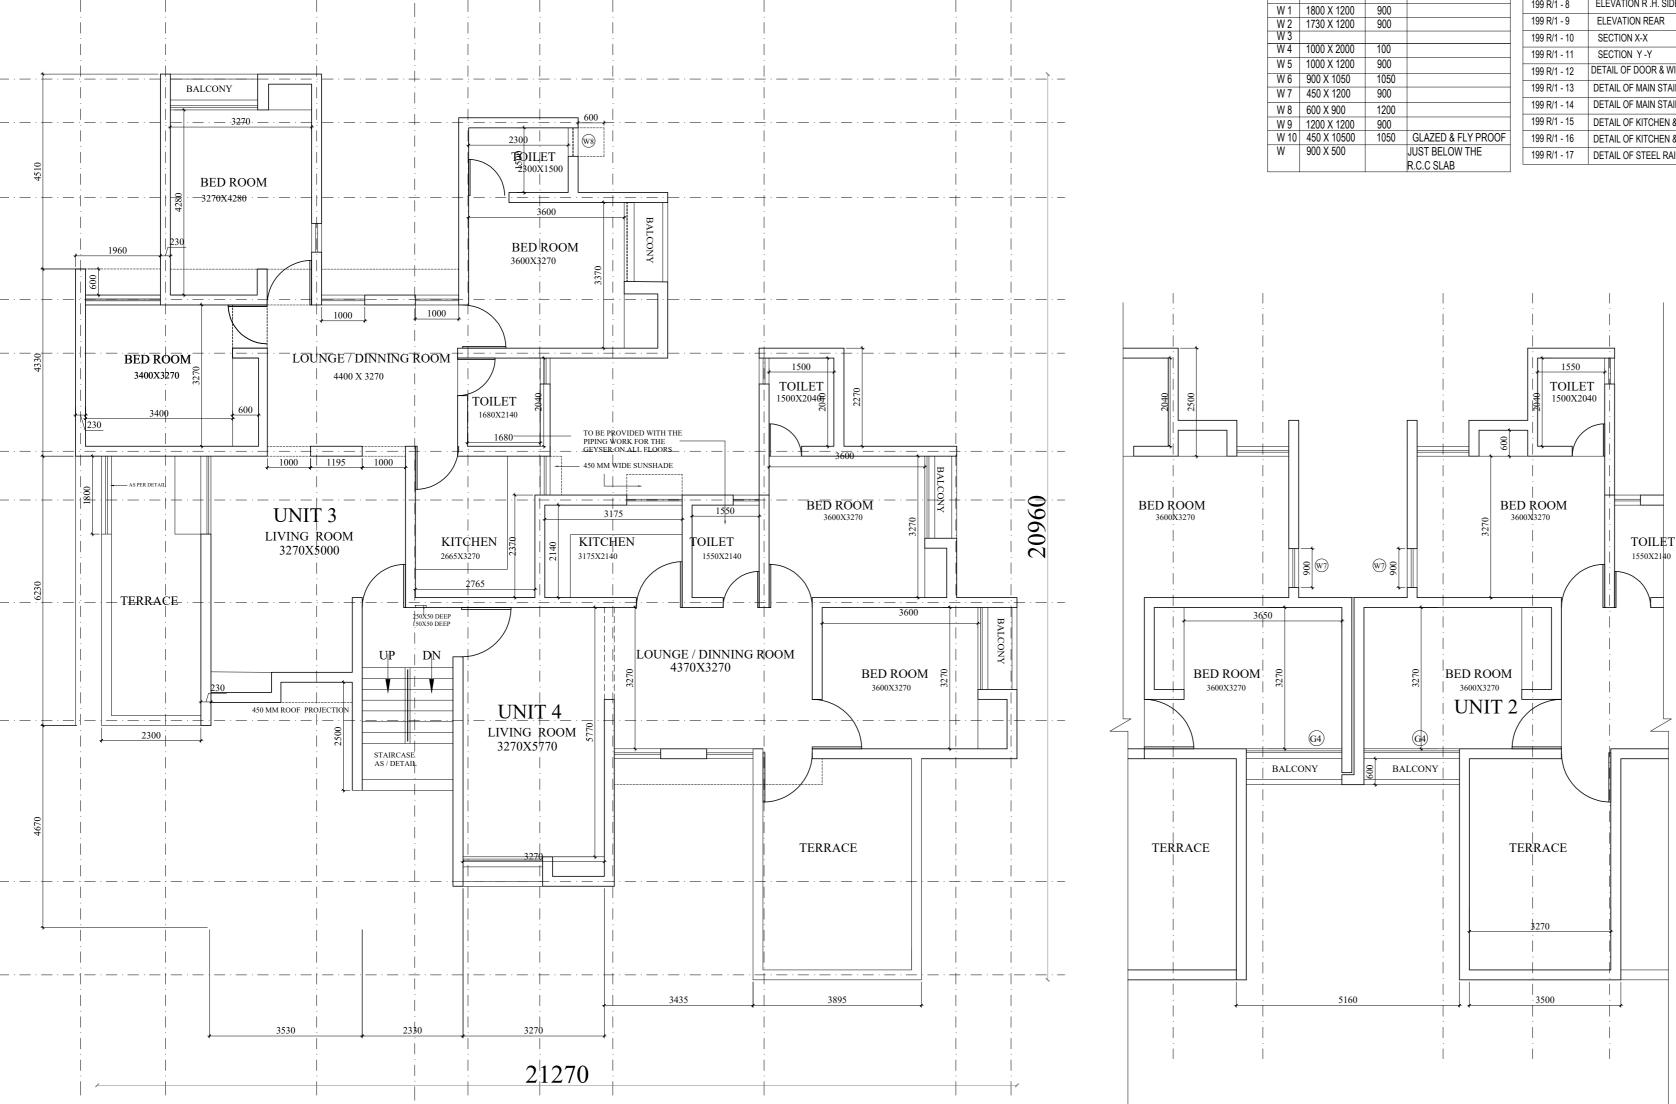

FIRST FLOOR PLAN

SCHE	HEDULE OF DOOR & WINDOW :		
TYPE	SIZE	SILL LVL	REMARK
G1	3200 X 2100	00	GLAZING AS / DETAIL
G 2	1800 X 2100	00	GLAZING AS / DETAIL
G 3	1000 X 2100	00	GLAZING AS / DETAIL
G 4	1980 X 2100	00	GLAZING AS / DETAIL
D 1	1000 X 2100	00	FLUSH DOOR
D 2	900 X 2100	00	PANEL AND JALI
D 3	750 X 2100	00	FLUSH DOOR
D 4	1000 X 2100	00	BRACED AND BATTEN
W 1	1800 X 1200	900	
W 2	1730 X 1200	900	
W 3			
W 4	1000 X 2000	100	
W 5	1000 X 1200	900	
W 6	900 X 1050	1050	
W 7	450 X 1200	900	
W 8	600 X 900	1200	
W 9	1200 X 1200	900	
W 10	450 X 10500	1050	GLAZED & FLY PROOF
W	900 X 500		JUST BELOW THE
			R.C.C SLAB

SCHEDULE OF DRAWINGS:			
SHEET NO	DESCRIPTION		
199 R/1 - 1	GROUND FLOOR PLAN		
199 R/1 - 2	FIRST FLOOR PLAN		
199 R/1 - 3	SECOND FLOOR PLAN		
199 R/1 - 4	THIRD FLOOR PLAN		
199 R/1 - 5	TERRACE FLOOR PLAN		
199 R/1 - 6	ELEVATION FRONT		
199 R/1 - 7	ELEVATION L.H. SIDE		
199 R/1 - 8	ELEVATION R .H. SIDE		
199 R/1 - 9	ELEVATION REAR		
199 R/1 - 10	SECTION X-X		
199 R/1 - 11	SECTION Y-Y		
199 R/1 - 12	DETAIL OF DOOR & WINDOWS		
199 R/1 - 13	DETAIL OF MAIN STAIRCASE		
199 R/1 - 14	DETAIL OF MAIN STAIRCASE		
199 R/1 - 15	DETAIL OF KITCHEN & TOILET		
199 R/1 - 16	DETAIL OF KITCHEN & TOILET		
199 R/1 - 17	DETAIL OF STEEL RAILING		
	,		

## JOINING DETAIL

DIGITIZED BY

allot por

RCH. ASS

SR. ARCHITECT

ADD. CH. ARCH.

CHIEF ARCH.



## HOUSING & URBAN PROJECT WINGS DATE : 4TH JAN 1983

#### SCHEDULE OF AREA:

	-/ \\		
AREA OF UNIT 1 :	CAT III	GROUND FLR	110.89 SQ.M.
AREA OF UNIT 2 :	CAT III	GROUND FLR	110.89 SQ.M.
AREA OF UNIT 3 :	CAT III	FIRST FLR	112.09 SQ.M.
AREA OF UNIT 4 :	CAT II	FIRST FLR	88.09 SQ.M.
AREA OF UNIT 5 :	CAT II	SECOND FLR	96.31 SQ.M.
AREA OF UNIT 6 :DUPLEX	CAT III	SECOND FLR	114.46 SQ.M.
AREA OF UNIT 7 :	CAT II	THIRD FLR	88.09 SQ.M.
AREA OF STAIRCASE ON EACH FLOOR			5.41 SQ.M.
AREA OF GARAGE			3.11 SQ.M.

NOTES:-

- ALL DIMENSIONS ARE IN MM. • DWG. NOT TO BE SCALED ONLY WRITTEN DIMENSION TO BE FOLLOWED.
- ALL DIMENSION SHOULD BE CHECKED AT SITE BEFORE EXECUTION OF WORK.
- STRUCTURAL DWG. SHOULD BE GET APPROVED BY ARCHITECT.
- ARCHITECT SHOULD BE CONSULTED AT THE TIME OF PREP. OF NIT.
- ELECTRICAL LAYOUT SHOULD BE GET APPROVED BY THE ARCHITECT.
- NOTHING SHOULD BE CHANGED WITHOUT THE CONSENT OF AN ARCHITECT.

SPECIFICATON:

- INSIDE FLOORING SHOULD BE MOSSIAC IN GREY CEMENT.
- ALL TOILETS SHALL HAVE 2100 HIGH GLAZED TILE DADO.
- KITCHEN SHOULD HAVE GLAZED TILE/MOSSAC DADO AS PER DETAIL.
- PCC TILES FLOORING ON TERRACE.
- STD. STEEL SECTION SHALL BE USED IN GLAZING & WINDOWS.
- PRESSED STEEL FRAMES SHALL BE USED IN DOORS.
- ANGLE IRON FRAME SHALL BE USED IN TERRACE.

STANDARD DESIGN FOR 3 BED

ROOM & 2 BED ROOM HOUSES

#### NOTE:

THIS DRAWING HAS BEEN DIGITIZED/ RASTERED IN AUTOCAD VERSION FROM ORIGINAL DRAWING (TRACING) STANDARD UNIT PLAN SCHEME NO.199R. FOR ANY OFFICIAL USE ORIGINAL TRACING NEEDS TO BE REFERRED.

PROJECT TITLE :

I	N
w	E
ç	3

DRG. NO.

SHEET	TITLE :	
FIRST	FLOOR	PLAN

IRST FLOO	R PLAN	Sch.no. 199R
ARCH. ASSTT.	ASSTT. ARCH.	ARCHITECT


SR. ARCHITECT	ADD. CH. ARCH.	CHIEF ARCH.

DATE : SEPT., 2010

SCALE : I:50	
--------------	--

H


HOUSING & URBAN PROJECT WING, OFFICE OF THE SR. ARCHITECT, EAST ZONE, VIKAS MINAR, D.D.A.

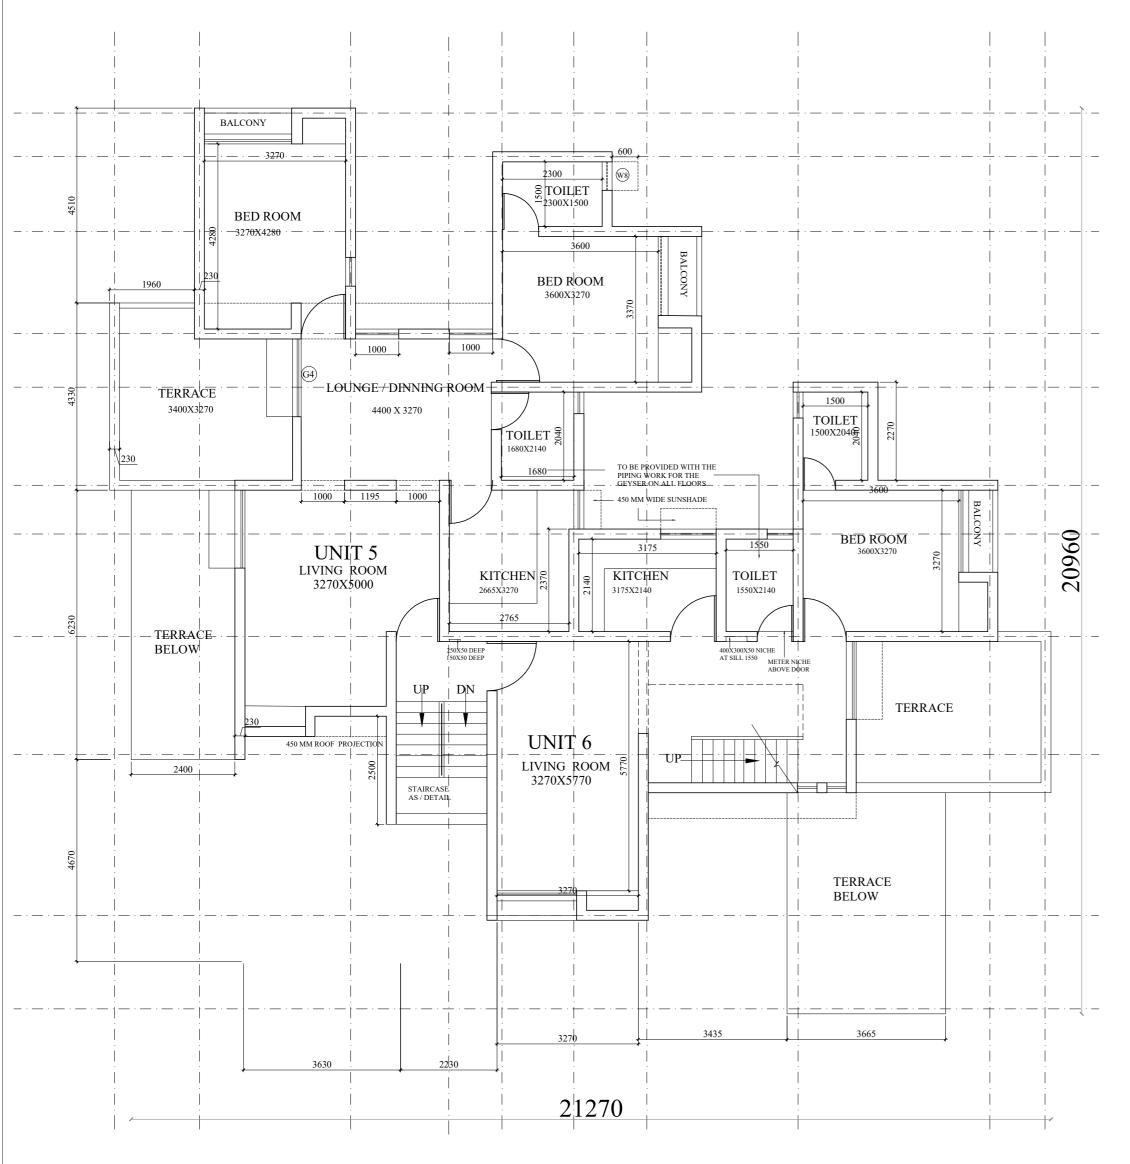

SECOND FLOOR PLAN

SCHE	EDULE OF D	000R &	WINDOW :
TYPE	SIZE	SILL LVL	REMARK
G1	3200 X 2100	00	GLAZING AS / DETAIL
G 2	1800 X 2100	00	GLAZING AS / DETAIL
G 3	1000 X 2100	00	GLAZING AS / DETAIL
G 4	1980 X 2100	00	GLAZING AS / DETAIL
D 1	1000 X 2100	00	FLUSH DOOR
D 2	900 X 2100	00	PANEL AND JALI
D 3	750 X 2100	00	FLUSH DOOR
D 4	1000 X 2100	00	BRACED AND BATTEN
W 1	1800 X 1200	900	
W 2	1730 X 1200	900	
W 3			
W 4	1000 X 2000	100	
W 5	1000 X 1200	900	
W 6	900 X 1050	1050	
W 7	450 X 1200	900	
W 8	600 X 900	1200	
W 9	1200 X 1200	900	
W 10	450 X 10500	1050	GLAZED & FLY PROOF
W	900 X 500		JUST BELOW THE
			R.C.C SLAB

SCHEDULE OF DRAWINGS:		
SHEET NO	DESCRIPTION	
199 R/1 - 1	GROUND FLOOR PLAN	
199 R/1 - 2	FIRST FLOOR PLAN	
199 R/1 - 3	SECOND FLOOR PLAN	
199 R/1 - 4	THIRD FLOOR PLAN	
199 R/1 - 5	TERRACE FLOOR PLAN	
199 R/1 - 6	ELEVATION FRONT	
199 R/1 - 7	ELEVATION L.H. SIDE	
199 R/1 - 8	ELEVATION R .H. SIDE	
199 R/1 - 9	ELEVATION REAR	
199 R/1 - 10	SECTION X-X	
199 R/1 - 11	SECTION Y-Y	
199 R/1 - 12	DETAIL OF DOOR & WINDOWS	
199 R/1 - 13	DETAIL OF MAIN STAIRCASE	
199 R/1 - 14	DETAIL OF MAIN STAIRCASE	
199 R/1 - 15	DETAIL OF KITCHEN & TOILET	
199 R/1 - 16	DETAIL OF KITCHEN & TOILET	
199 R/1 - 17	DETAIL OF STEEL RAILING	

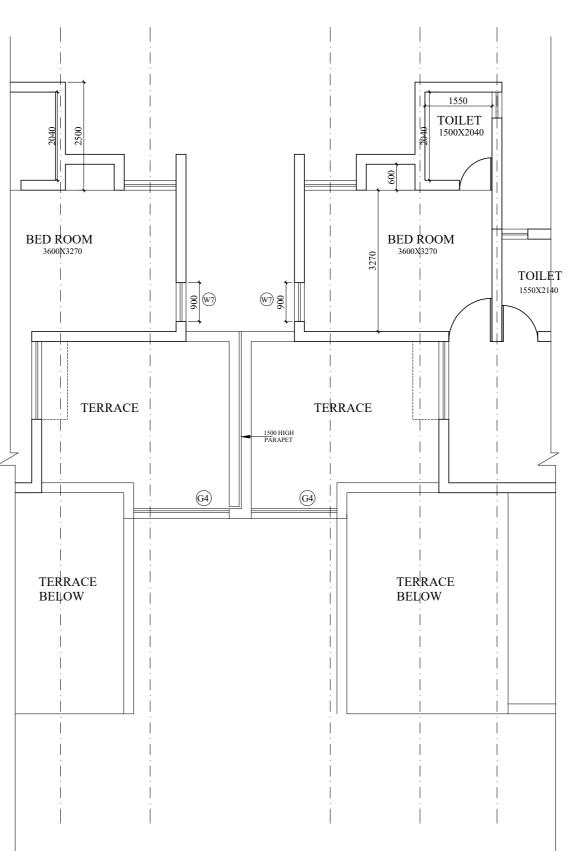

# JOINING DETAIL

DIGITIZED BY



## HOUSING & URBAN PROJECT WINGS DATE: 4TH JAN 1983

#### SCHEDULE OF AREA:

AREA OF UNIT 1 :	CAT III	GROUND FLR	110.89 SQ.M.
AREA OF UNIT 2 :	CAT III	GROUND FLR	110.89 SQ.M.
AREA OF UNIT 3 :	CAT III	FIRST FLR	112.09 SQ.M.
AREA OF UNIT 4 :	CAT II	FIRST FLR	88.09 SQ.M.
AREA OF UNIT 5 :	CAT II	SECOND FLR	96.31 SQ.M.
AREA OF UNIT 6 :DUPLEX	CAT III	SECOND FLR	114.46 SQ.M.
AREA OF UNIT 7 :	CAT II	THIRD FLR	88.09 SQ.M.
AREA OF STAIRCASE ON EACH FLOOR			5.41 SQ.M.
AREA OF GARAGE			3.11 SQ.M.

NOTES:-

- ALL DIMENSIONS ARE IN MM.
  DWG. NOT TO BE SCALED ONLY WRITTEN DIMENSION TO BE FOLLOWED.
- ALL DIMENSION SHOULD BE CHECKED AT SITE BEFORE EXECUTION OF WORK.
- STRUCTURAL DWG. SHOULD BE GET APPROVED BY ARCHITECT.
- ARCHITECT SHOULD BE CONSULTED AT THE TIME OF PREP. OF NIT.
- ELECTRICAL LAYOUT SHOULD BE GET APPROVED BY THE ARCHITECT.
- NOTHING SHOULD BE CHANGED WITHOUT THE CONSENT OF AN ARCHITECT.

SPECIFICATON:

- INSIDE FLOORING SHOULD BE MOSSIAC IN GREY CEMENT.
- ALL TOILETS SHALL HAVE 2100 HIGH GLAZED TILE DADO.
- KITCHEN SHOULD HAVE GLAZED TILE/MOSSAC DADO AS PER DETAIL.
- PCC TILES FLOORING ON TERRACE.
- STD. STEEL SECTION SHALL BE USED IN GLAZING & WINDOWS.
- PRESSED STEEL FRAMES SHALL BE USED IN DOORS.
- ANGLE IRON FRAME SHALL BE USED IN TERRACE.


STANDARD DESIGN FOR 3 BED

ROOM & 2 BED ROOM HOUSES

#### NOTE:

THIS DRAWING HAS BEEN DIGITIZED/ RASTERED IN AUTOCAD VERSION FROM ORIGINAL DRAWING (TRACING) STANDARD UNIT PLAN SCHEME NO.199R. FOR ANY OFFICIAL USE ORIGINAL TRACING NEEDS TO BE REFERRED.

PROJECT TITLE :

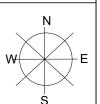

DRG. NO.

Sch.no. 199R

SHEET TITLE : FIRST FLOOR PLAN

ARCH. ASSTT.	ASSTT. ARCH.	ARCHITECT
SR. ARCHITECT	ADD. CH. ARCH.	CHIEF ARCH.

DATE : SEPT., 2010


SCALE : 1:50

HOUSING & URBAN PROJECT WING, OFFICE OF THE SR. ARCHITECT, EAST ZONE, VIKAS MINAR, D.D.A.

ARCH. ASSTT. ASSTT. ARCH. SR. ARCHITECT ADD. CH. ARCH.



# THIRD FLOOR PLAN

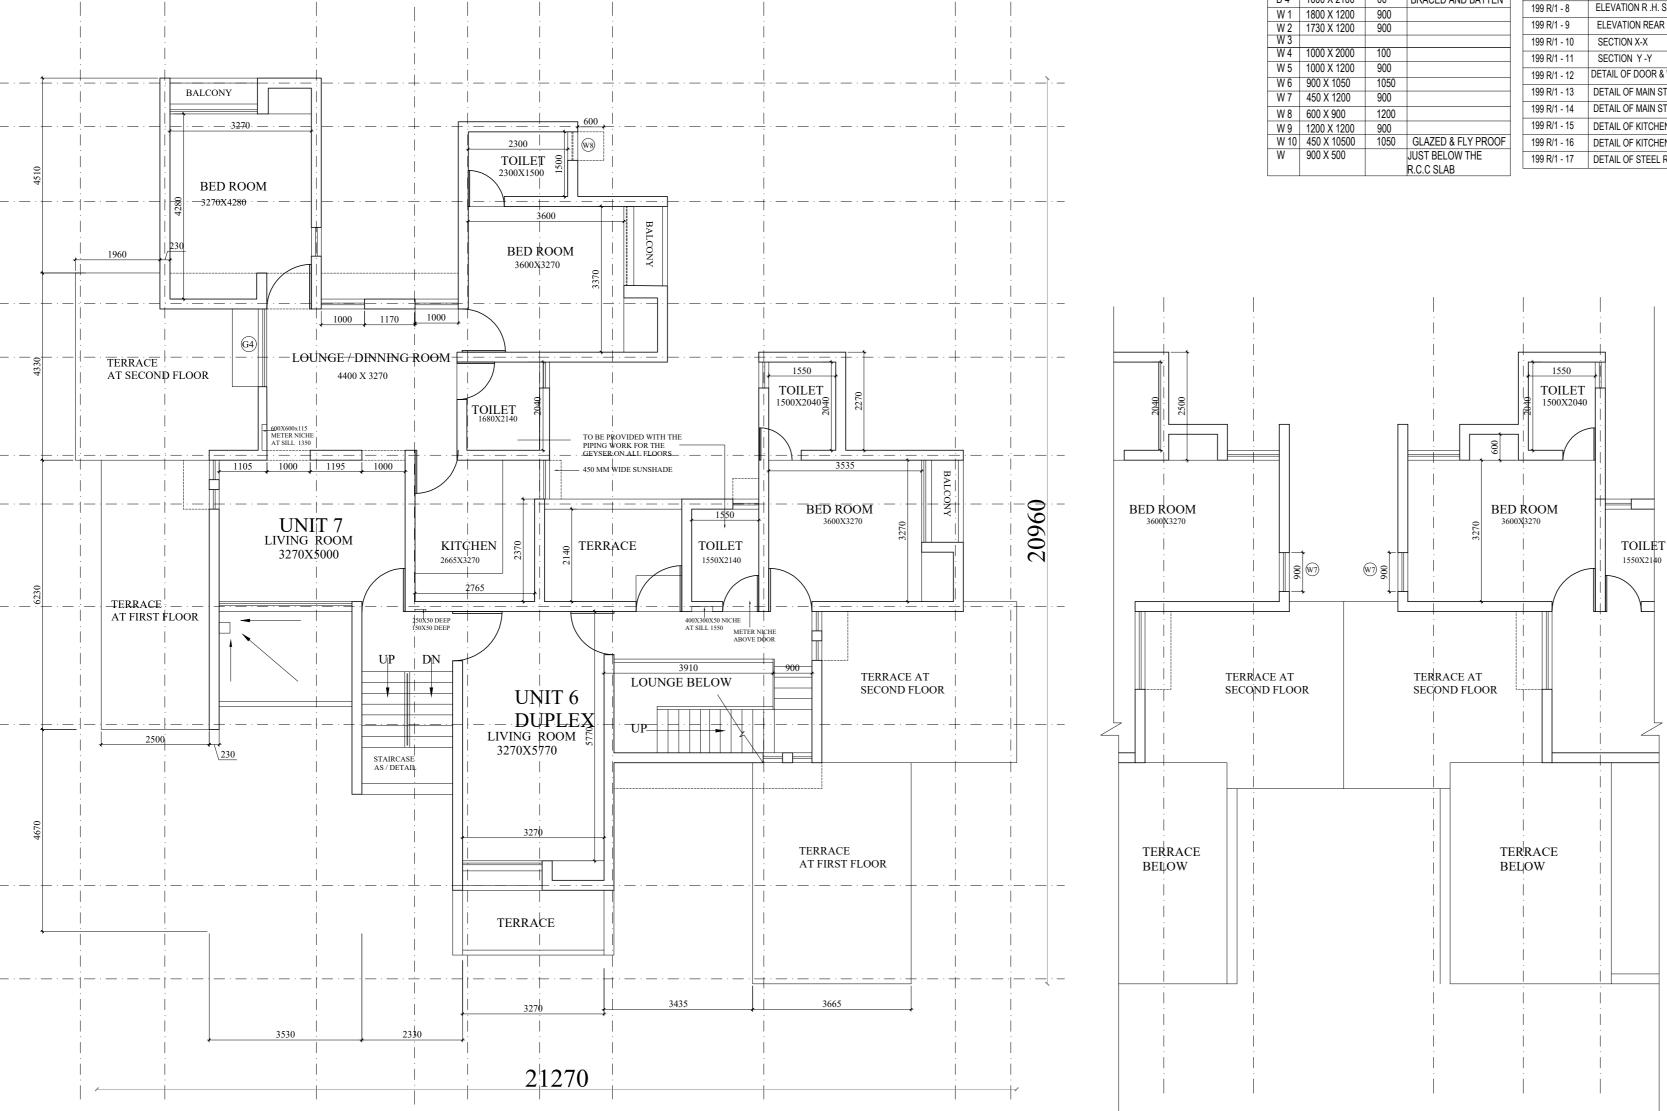

SCHE	HEDULE OF DOOR & WINDOW :		
TYPE	SIZE	SILL LVL	REMARK
G1	3200 X 2100	00	GLAZING AS / DETAIL
G 2	1800 X 2100	00	GLAZING AS / DETAIL
G 3	1000 X 2100	00	GLAZING AS / DETAIL
G 4	1980 X 2100	00	GLAZING AS / DETAIL
D1	1000 X 2100	00	FLUSH DOOR
D 2	900 X 2100	00	PANEL AND JALI
D 3	750 X 2100	00	FLUSH DOOR
D 4	1000 X 2100	00	BRACED AND BATTEN
W 1	1800 X 1200	900	
W 2	1730 X 1200	900	
W 3			
W 4	1000 X 2000	100	
W 5	1000 X 1200	900	
W 6	900 X 1050	1050	
W 7	450 X 1200	900	
W 8	600 X 900	1200	
W 9	1200 X 1200	900	
W 10	450 X 10500	1050	GLAZED & FLY PROOF
W	900 X 500		JUST BELOW THE
			R.C.C SLAB

SCHEDULE OF DRAWINGS:		
SHEET NO	DESCRIPTION	
199 R/1 - 1	GROUND FLOOR PLAN	
199 R/1 - 2	FIRST FLOOR PLAN	
199 R/1 - 3	SECOND FLOOR PLAN	
199 R/1 - 4	THIRD FLOOR PLAN	
199 R/1 - 5	TERRACE FLOOR PLAN	
199 R/1 - 6	ELEVATION FRONT	
199 R/1 - 7	ELEVATION L.H. SIDE	
199 R/1 - 8	ELEVATION R .H. SIDE	
199 R/1 - 9	ELEVATION REAR	
199 R/1 - 10	SECTION X-X	
199 R/1 - 11	SECTION Y-Y	
199 R/1 - 12	DETAIL OF DOOR & WINDOWS	
199 R/1 - 13	DETAIL OF MAIN STAIRCASE	
199 R/1 - 14	DETAIL OF MAIN STAIRCASE	
199 R/1 - 15	DETAIL OF KITCHEN & TOILET	
199 R/1 - 16	DETAIL OF KITCHEN & TOILET	
199 R/1 - 17	DETAIL OF STEEL RAILING	

# JOINING DETAIL



## HOUSING & URBAN PROJECT WINGS DATE : 4TH JAN 1983

## 

SCHEDULE OF ARE	:A:		
AREA OF UNIT 1 :	CAT III	GROUND FLR	110.89 SQ.M.
AREA OF UNIT 2 :	CAT III	GROUND FLR	110.89 SQ.M.
AREA OF UNIT 3 :	CAT III	FIRST FLR	112.09 SQ.M.
AREA OF UNIT 4 :	CAT II	FIRST FLR	88.09 SQ.M.
AREA OF UNIT 5 :	CAT II	SECOND FLR	96.31 SQ.M.
AREA OF UNIT 6 :DUPLEX	CAT III	SECOND FLR	114.46 SQ.M.
AREA OF UNIT 7 :	CAT II	THIRD FLR	88.09 SQ.M.
AREA OF STAIRCASE ON EACH FLOOR			5.41 SQ.M.
AREA OF GARAGE			3.11 SQ.M.

NOTES:-

- ALL DIMENSIONS ARE IN MM. • DWG. NOT TO BE SCALED ONLY WRITTEN DIMENSION TO BE FOLLOWED.
- ALL DIMENSION SHOULD BE CHECKED AT SITE BEFORE EXECUTION OF WORK.
- STRUCTURAL DWG. SHOULD BE GET APPROVED BY ARCHITECT.
- ARCHITECT SHOULD BE CONSULTED AT THE TIME OF PREP. OF NIT.
- ELECTRICAL LAYOUT SHOULD BE GET APPROVED BY THE ARCHITECT.
- NOTHING SHOULD BE CHANGED WITHOUT THE CONSENT OF AN ARCHITECT.

SPECIFICATON:

- INSIDE FLOORING SHOULD BE MOSSIAC IN GREY CEMENT.
- ALL TOILETS SHALL HAVE 2100 HIGH GLAZED TILE DADO.
- KITCHEN SHOULD HAVE GLAZED TILE/MOSSAC DADO AS PER DETAIL.
- PCC TILES FLOORING ON TERRACE.
- STD. STEEL SECTION SHALL BE USED IN GLAZING & WINDOWS.
- PRESSED STEEL FRAMES SHALL BE USED IN DOORS.
- ANGLE IRON FRAME SHALL BE USED IN TERRACE.

STANDARD DESIGN FOR 3 BED

ROOM & 2 BED ROOM HOUSES

#### NOTE:

THIS DRAWING HAS BEEN DIGITIZED/ RASTERED IN AUTOCAD VERSION FROM ORIGINAL DRAWING (TRACING) STANDARD UNIT PLAN SCHEME NO.199R. FOR ANY OFFICIAL USE ORIGINAL TRACING NEEDS TO BE REFERRED.

PROJECT TITLE :

I	N
W	E

DRG. NO.

SHEET	TITLE :	
FIRST	FLOOR	PLAN

IRST FLOO	Sch.no. 199R	
ARCH. ASSTT.	ASSTT. ARCH.	ARCHITECT

SR. ARCHITECT	ADD. CH. ARCH.	CHIEF ARCH.

DATE : SEPT., 2010

SCALE : 1:50

<u> </u>	<u> </u>
H	W

Ramages

CHIEF ARCH.

HOUSING & URBAN PROJECT WING, OFFICE OF THE SR. ARCHITECT, EAST ZONE, VIKAS MINAR, D.D.A.

Allor Jos ARCH. ASS ADD. CH. ARCH. SR. ARCHITECT

DIGITIZED BY